


- TYPE "B" INLET FRAME AND GRATE TO BE CAMPBELL FOUNDRY CASTING NUMBER 2618 TYPE "J" BICYCLE SAFE GRATE OR APPROVED EQUAL.
- 2. TYPE "E" INLET FRAME AND GRATE TO BE CAMPBELL FOUNDRY CASTING NUMBER 3425 BICYCLE SAFE GRATE OR APPROVED FOLIAL

"DETECTABLE WARNING PLATES SHALL BE RED VITRIFED POLYMER COMPOSITE (VPC) CAST

SECTION THROUGH CURB RAMPS 1

THROUGH 6


- 3. TYPE "A" INLET FRAME AND GRATE TO BE CAMPBELL FOUNDRY CASTING NUMBER 3405 BICYCLE SAFE GRATE OR APPROVED
- 4. ALL GRATES AND HEADERS SHALL BE PHASE II STORM WATER COMPLIANT WITH WORDS "DUMP NO WASTE DRAINS TO WATERWAYS" AND FISH SYMBOL CAST ON THEM.
- 5. "B" INLET HEADERS SHALL BE 8" HIGH AND 8" WIDE ON TOP TO MATCH PROPOSED CURB.
- CONTRACTOR IS RESPONSIBLE TO ORDER CORRECT SIZE GRATES AND HEADERS AS SPECIFIED TO MATCH EXISTING INLET FRAMES AND HEADERS BETWEEN EXISTING CURBS TO REMAIN.
- THE CONTRACTOR IS RESPONSIBLE TO REMOVE DEBRIS FROM ALL INLETS LOCATED WITHIN THE SCOPE OF WORK.
- 2. INLET REHABILITATION SHALL INCLUDE REMOVING THE EXISTING CASTINGS; REPAIR EXISTING WALLS, LADDER RUNGS AND REPAIR OR INSTALL A NEW LOW FLOW CHANNEL. IN ADDITION, THE INSIDE OF THE INLET SHALL BE PARGED WITH A & THICK COAT OF APPROVED WATERPROOF CEMENT TROWELED TO A SMOOTH FINISH AND THE NEW CASTING SET TO GRADE WITH WATERPROOF CEMENT TROWELED AROUND THE OUTSIDE OF THE INLET FRAME. BACKFILLING SHALL BE DONE WITH SUITABLE MATERIAL IN LIFTS OF SIX (6) INCHES OR LESS AND COMPACTED AS SPECIFIED.
- 3. PAVEMENT TO BE MILLED AND REPAVED SURROUNDING THE EXISTING INLET SHALL BE PAVED SUCH THAT TO ALLOW POSITIVE DRAINAGE INTO THE CATCH BASIN. UNLESS NOTED IN THESE PLANS, THE CONTRACTOR SHALL NOT ALTER THE ELEVATION OF THE NEW FRAME AND GRATES FROM EXISTING CONDITIONS UNLESS APPROVED BY THE TOWNSHIP DPW OR THE ENGINEER.

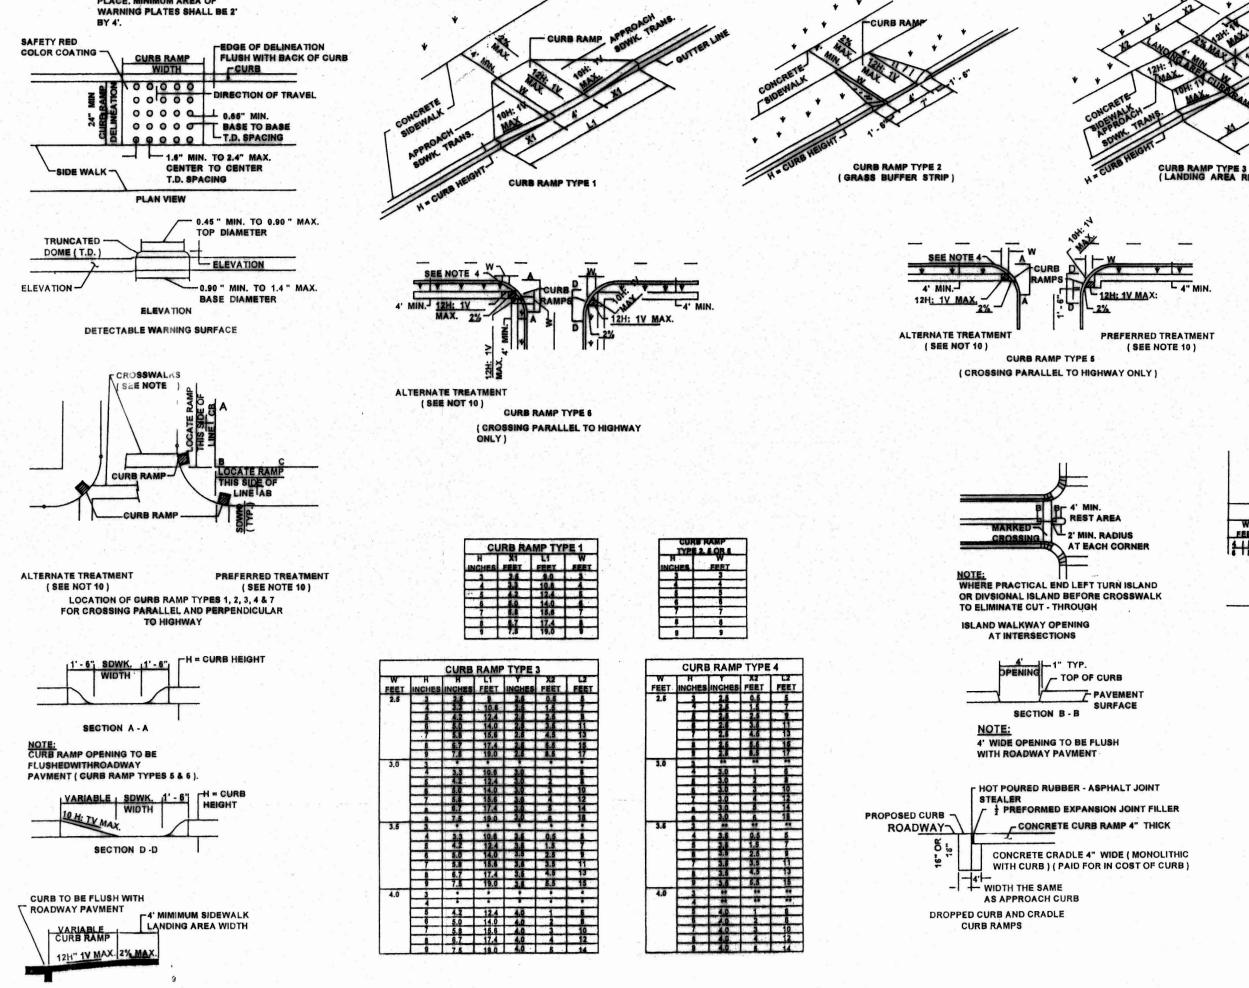

HANDICAP ACCESSIBLE RAMP DETAIL

VARIES - MILL 2" OFF ENTIRE ROAD (PETROMAT 4598) -- MILL 2" ALONG FACE OF CURB. REPLACE EXISTING WITH BITUMINOUS SURFACE COURSE, MIX - CONCRETE CURB 1-4 (2" THICK),(TYP.) EXISTING 5" TO 5 1/2" ASPHALT BASE REPAIRS, MILL ROAD AN PAVING FABRIC ADDITIONAL 2" ALONG CUTTER AND 3" (PETROMAT 4598) ----IN THE CROWN (LEAVING APPROX. 1" ---OF EXISTING ASPHALT). REPLACE WITH BITUMINOUS STABILIZED BASE, MIX 1-2 (3" THICK)

TYPICAL ROADWAY & MILLING SECTION

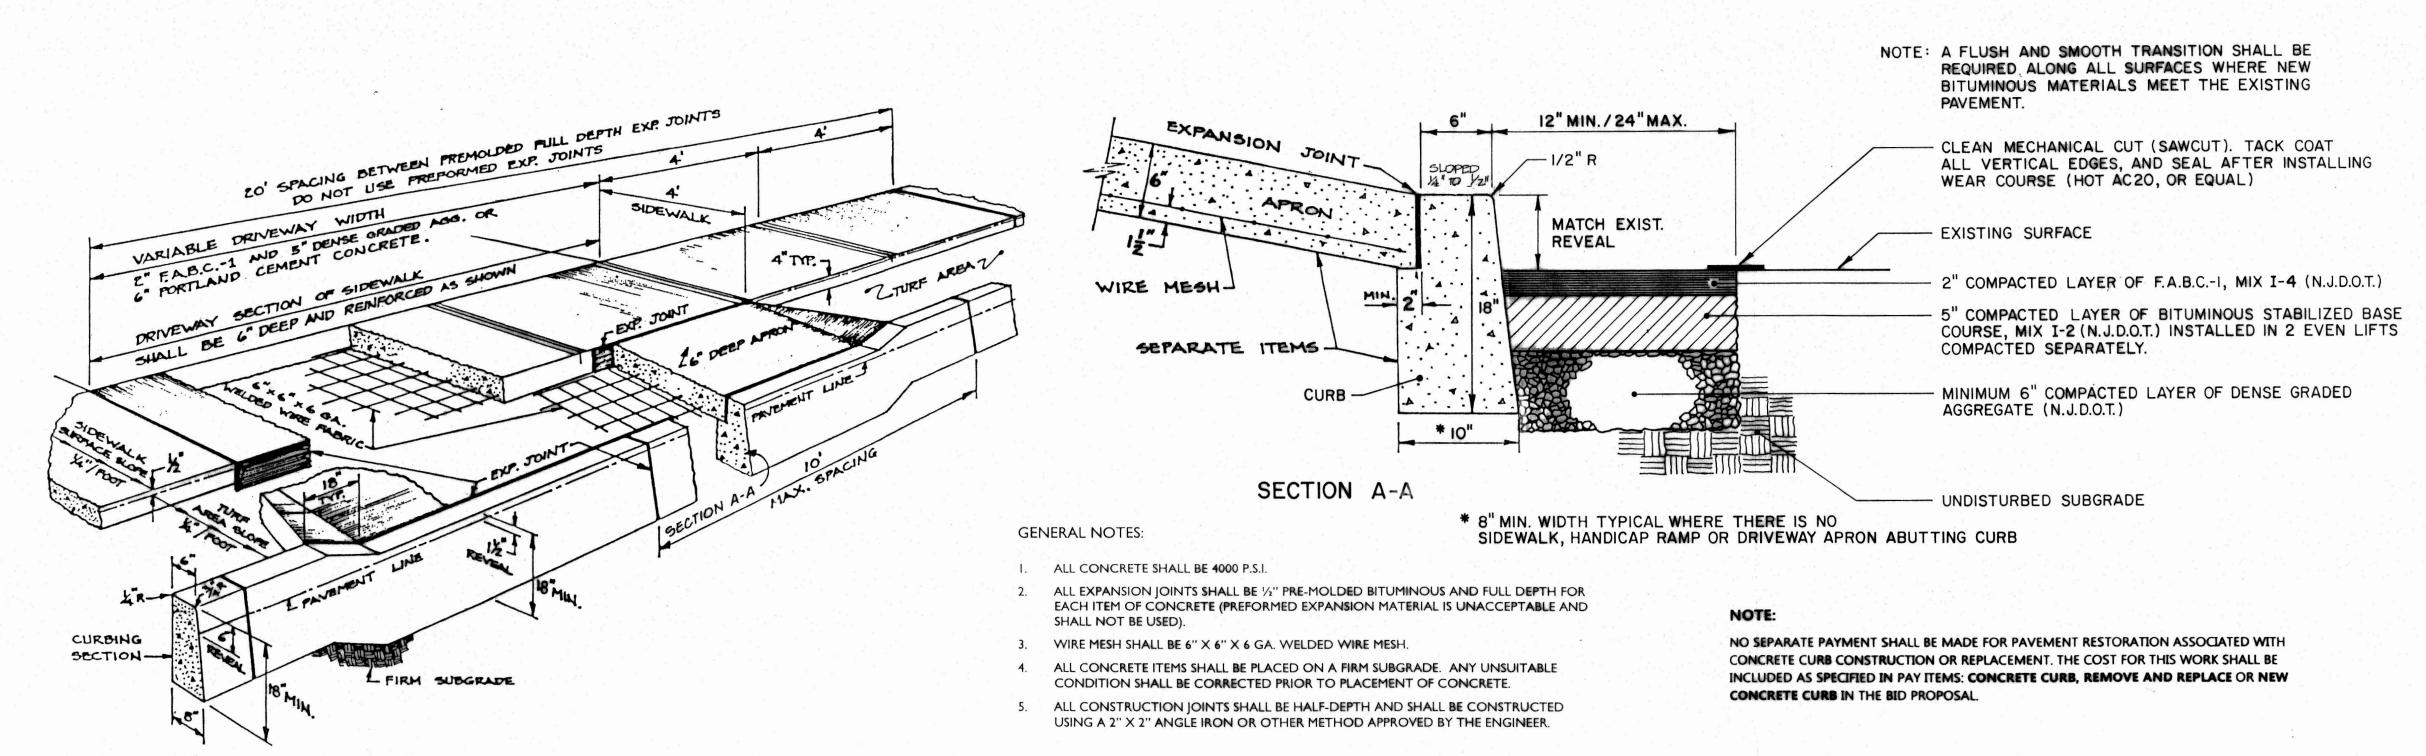

CONCRETE SIDEWALK & DRIVEWAY APRON DETAIL

GENERAL NOTES:

AT ALL CURB RAMPS

CONCRETE HEADER WHER

CURB RAMP SHALL BE KEPT CLEAR OF OBSTRUCTIONS

SIDEWALK OF THE APPROPRIATE ADJACENT THICKNESS.

SIDEWALK VARY DRASTICALLY IN AREA OF PROPOSED CURB RAMP.

1. THE LOCATION OF EXISTING UTILITIES SHOWN ON THIS PLAN HAS BEEN TAKEN FROM VARIOUS SOURCES AND IS SHOWN FOR DESIGN AND ESTIMATING PUROSES ONLY. ACTUAL LOCATIONS OF UTILITIES SHALL BE FIELD VERIFIED. ANY DESCREPANCIES OR APPARENT CONFLICTS SHALL BE CALLED TO THE ATTENTION OF THE ENGINEER FOR INTERPRETATION. CONTRACTORS ARE ADVISED TO CALL 1-800-272-1000 BEFORE COMMENCING CONSTRUCTION FOR A MARKOUT OF EXISTING UTILITES.

I. WHÈRE PRACTICAL END LEFT TURN ISLAND LANDING AREA, APPROACH SIDEWALK TRANSITIONS, AND

3. CURB (DROPPED CURB) GUTTERLINE TO BE FLUSH WITH ROADWAY PAVEMENT A MINIMUM OF 4 FEET

A. FOR CURB RAMP TYPES 5 AND 6, IF A GRASS BUFFER DOES NOT EXIST, SLOPE CURB TO EQUAL SLOPE OF ADJACENT CURB RAMP.

5. SIDEWALK AND CURB RAMP WITHIN AREA ENCLOSED BY HEAVY LINES TO BE PAID FOR AS CONCRETE

6. CURB AND HEADER WITHIN AREA ENCLOSED BY HEAVY LINES TO BE PAID FOR AS VERTICAL CURB OF SLOPE CURB OF THE APPROPRIATE ADJACENT SIZE AND KIND.
7. WHERE THE DISTANCE FROM GUTTER LINE TO THE OUTSIDE EDGE OF SIDEWALK IS 6 FEET OR LESS,

8. THE PUBLIC SIDEWALK CURB RAMP. DETECTABLE WARNING SURFACE (SHADED AREA) SHALL BE REI 9. CROSSWALKS AND STOP LINES MAY BE MARKED OR UNMARKED, SEE PLANS.

ARE OTHER THAN WHAT IS PROVIDED IN THE TABLES, THE DIMENSIONS OF THE RAMPS WILL HAVE TO BE CALCULATED BASED ON CROSS SLOPES SHOWN

HMA = HOT MIX ASPHALT

CURB RAMP TYPE 7 SHOULD BE USED, INSTEAD OF CURB RAMP TYPE 1 THROUGH 4.

0. PREFERRED AND ALTERNATE TREATMENTS SHOULD NOT BE INTERMIXED WITHIN THE SAME

11. DIMENSIONS SHOWN IN TABLES ARE FOR 3 INCHES CURB HEIGHTS. WHERE THE CURB HEIGHTS

2. DIMENSIONS SHOWN IN TABLES ARE FOR RELATIVELY FLAT SIDEWALK AREAS. CARE SHOULD BE TAKEN WHEN DETERMINING CURB RAMP SIZE BASED ON CURB HEIGHT (H) WHERE ELEVATION OF CURB AND

GRASS BUFFER STRIP WITH

- EXISTING UTILITIES INCLUDING VALVE BOXES, CLEAN OUTS, CURB STOPS, MANHOLES, METERS, ETC. SHALL BE ADJUSTED TO MATCH PROPOSED FINISHED GRADE. STORM DRAINAGE STRUCTURES SHALL NOT BE ADJUSTED UNLESS SPECIFICALLY CALLED FOR.
- 3. WHERE PROPOSED PAVEMENT ABUTS EXISTING PAVEMENT, THE EXISTING PAVEMENT SHALL BE SAW-CUT TO PROVIDE A SMOOTH VERTICAL EDGE. ALL ASPHALT JOINTS SHALL BE SEALED WITH A HOT POURED ASPHALT JOINT SEALER CONFORMING TO THE REQUIREMENTS OF ASTM DI 190. ALL EXISTING JOINTS SHALL BE SEALED PRIOR TO PLACEMENT OF THE FABC OVERLAY.
- 4. THE CONTRACTOR SHALL PROPERLY DISPOSE OF ALL SPOILS AND EXCAVATED MATERIALS
- 5. INSPECTION OF, OR FAILURE TO INSPECT ANY MATERIALS OR WORKMANSHIP BY THE ENGINEER SHALL IN NO WAY RELEIVE THE CONTRACTOR OF THE RESPONSIBILITY TO PERFORM THE WORK IN ACCORDANCE WITH THE PLANS, SPECIFICATIONS AND APPLICABLE LAWS.
- 6. MEET EXISTING GRADES AT ALL LIMITS OF CONSTRUCTION.
- 7. PAYEMENT MARKINGS AND SIGNS ARE TO CONFORM WITH THE MANUAL ON UNIFORM TRAFFIC CONTOL DEVICES.
- 8. CONTRACTOR SHALL MAINTAIN TRAFFIC DURING CONSTRUCTION.
- CONTRACTOR TO INSTALL AND MAINTAIN ALL SOIL EROSION CONTROL MEASURES
 DURING CONSTRUCTION. COSTS TO BE INCLUDED IN LUMP SUM AMOUNT FOR ITEM
 TURF REPAIR. THE ITEMS SHALL INCLUDE SILT FENCE, INLET PROTECTION, ETC.
- 10. ALL EXISTING MUA MANHOLE FRAMES AND COVERS SHALL MATCH FINAL PAVEMENT GRADE. IF NECESSARY, FRAMES AND COVERS SHALL BE ADJUSTED TO GRADE WITH CONCRETE RINGS AND NON-SHRINK GROUT IN CONFORMANCE WITH EWMUA RULES AND REGULATIONS.
- 11. ALL BACKFILL AND BITUMINOUS MATERIALS SHALL BE INSTALLED IN A MANNER CONSISTENT WITH TOWNSHIP ORDINANCE NOS. 15-1.9 AND 15-1.10 RULES AND REGULATIONS FOR EXCAVATIONS AND SURFACE RESTORATION. CONTRACTOR SHALL ALSO PROVIDE THE APPROPRIATE PROCEDURE TO ESTABLISH AND CERTIFY A MIN. OF 95% MOD. PROCTOR DENSITY OF ALL COMPACTED BACKFILL MATERIAL, SUBJECT TO TOWNSHIP APPROVAL.

NOTES & DETAILS

ROAD IMPROVEMENTS FOR
EDWARD DRIVE, LYNNFIELD DRIVE,
MAPLE STREAM ROAD & POPLAR RUN

	MAPLE STREAM ROAD & POPLAR RUN			
	DRAWN: MBL	EAST WINDSOR	DATE	NO.
	APPROVED: RC	TOWNSHIP MERCER COUNTY, N.J. 16 LANNING BOULEVARD		
	DATE: 4/12/23			*
	SCALE: AS NOTED			
S.	SHEET NO. 5 of 5	EAST WINDSOR, N.J.	REVISIONS	